FOOTING FOR GATE HOLDBACK

COMPACTED CRUSHED — STONE ROAD BASE TYPE "A" ODOT 1 1/4" AGGREGATE BASE


STEP #4 STEP #3 STEP #2


> DESIGN CONTOUR ADJUSTMENTS 4/0 COPPER GROUND GRID CONDUCTOR


NEW 3/4"x10' COPPER-CLAD (10 MIL) GROUND ROD EXOTHERMICALLY WELDED CONNECTION
(EXCEPTIONS: CONNECTIONS TO BOTTOM OF CLIMBING AND WAVEGUIDE LADDERS MAY BE BY GROUNDING LUGS, AND CONNECTIONS TO FENCE


POSTS MAY BE BY GROUND CLAMPS) Reference Old drawing number:

				UNITED STATES DEPARTMENT OF ENERGY SOUTHWESTERN POWER ADMINISTRATION TULSA, OKLAHOMA				
				WELEETKA RADIO STATION SITE AND GROUNDING PLAN NEW TOWER AND SITE IMPROVEMENTS				
				SCALE	1" = 10'-0"	DRAWING NUMBER		
				DRAWN	DK	RS19-C8004		
				CHECKED	НМ	1/213-0	0004	
				SUBMITTED	НМ	FILE NAME	SHEET NUMBER	
REV	DESCRIPTION	DRAWN	CHKD	APPROVED	LH	C8004	1 OF 1	

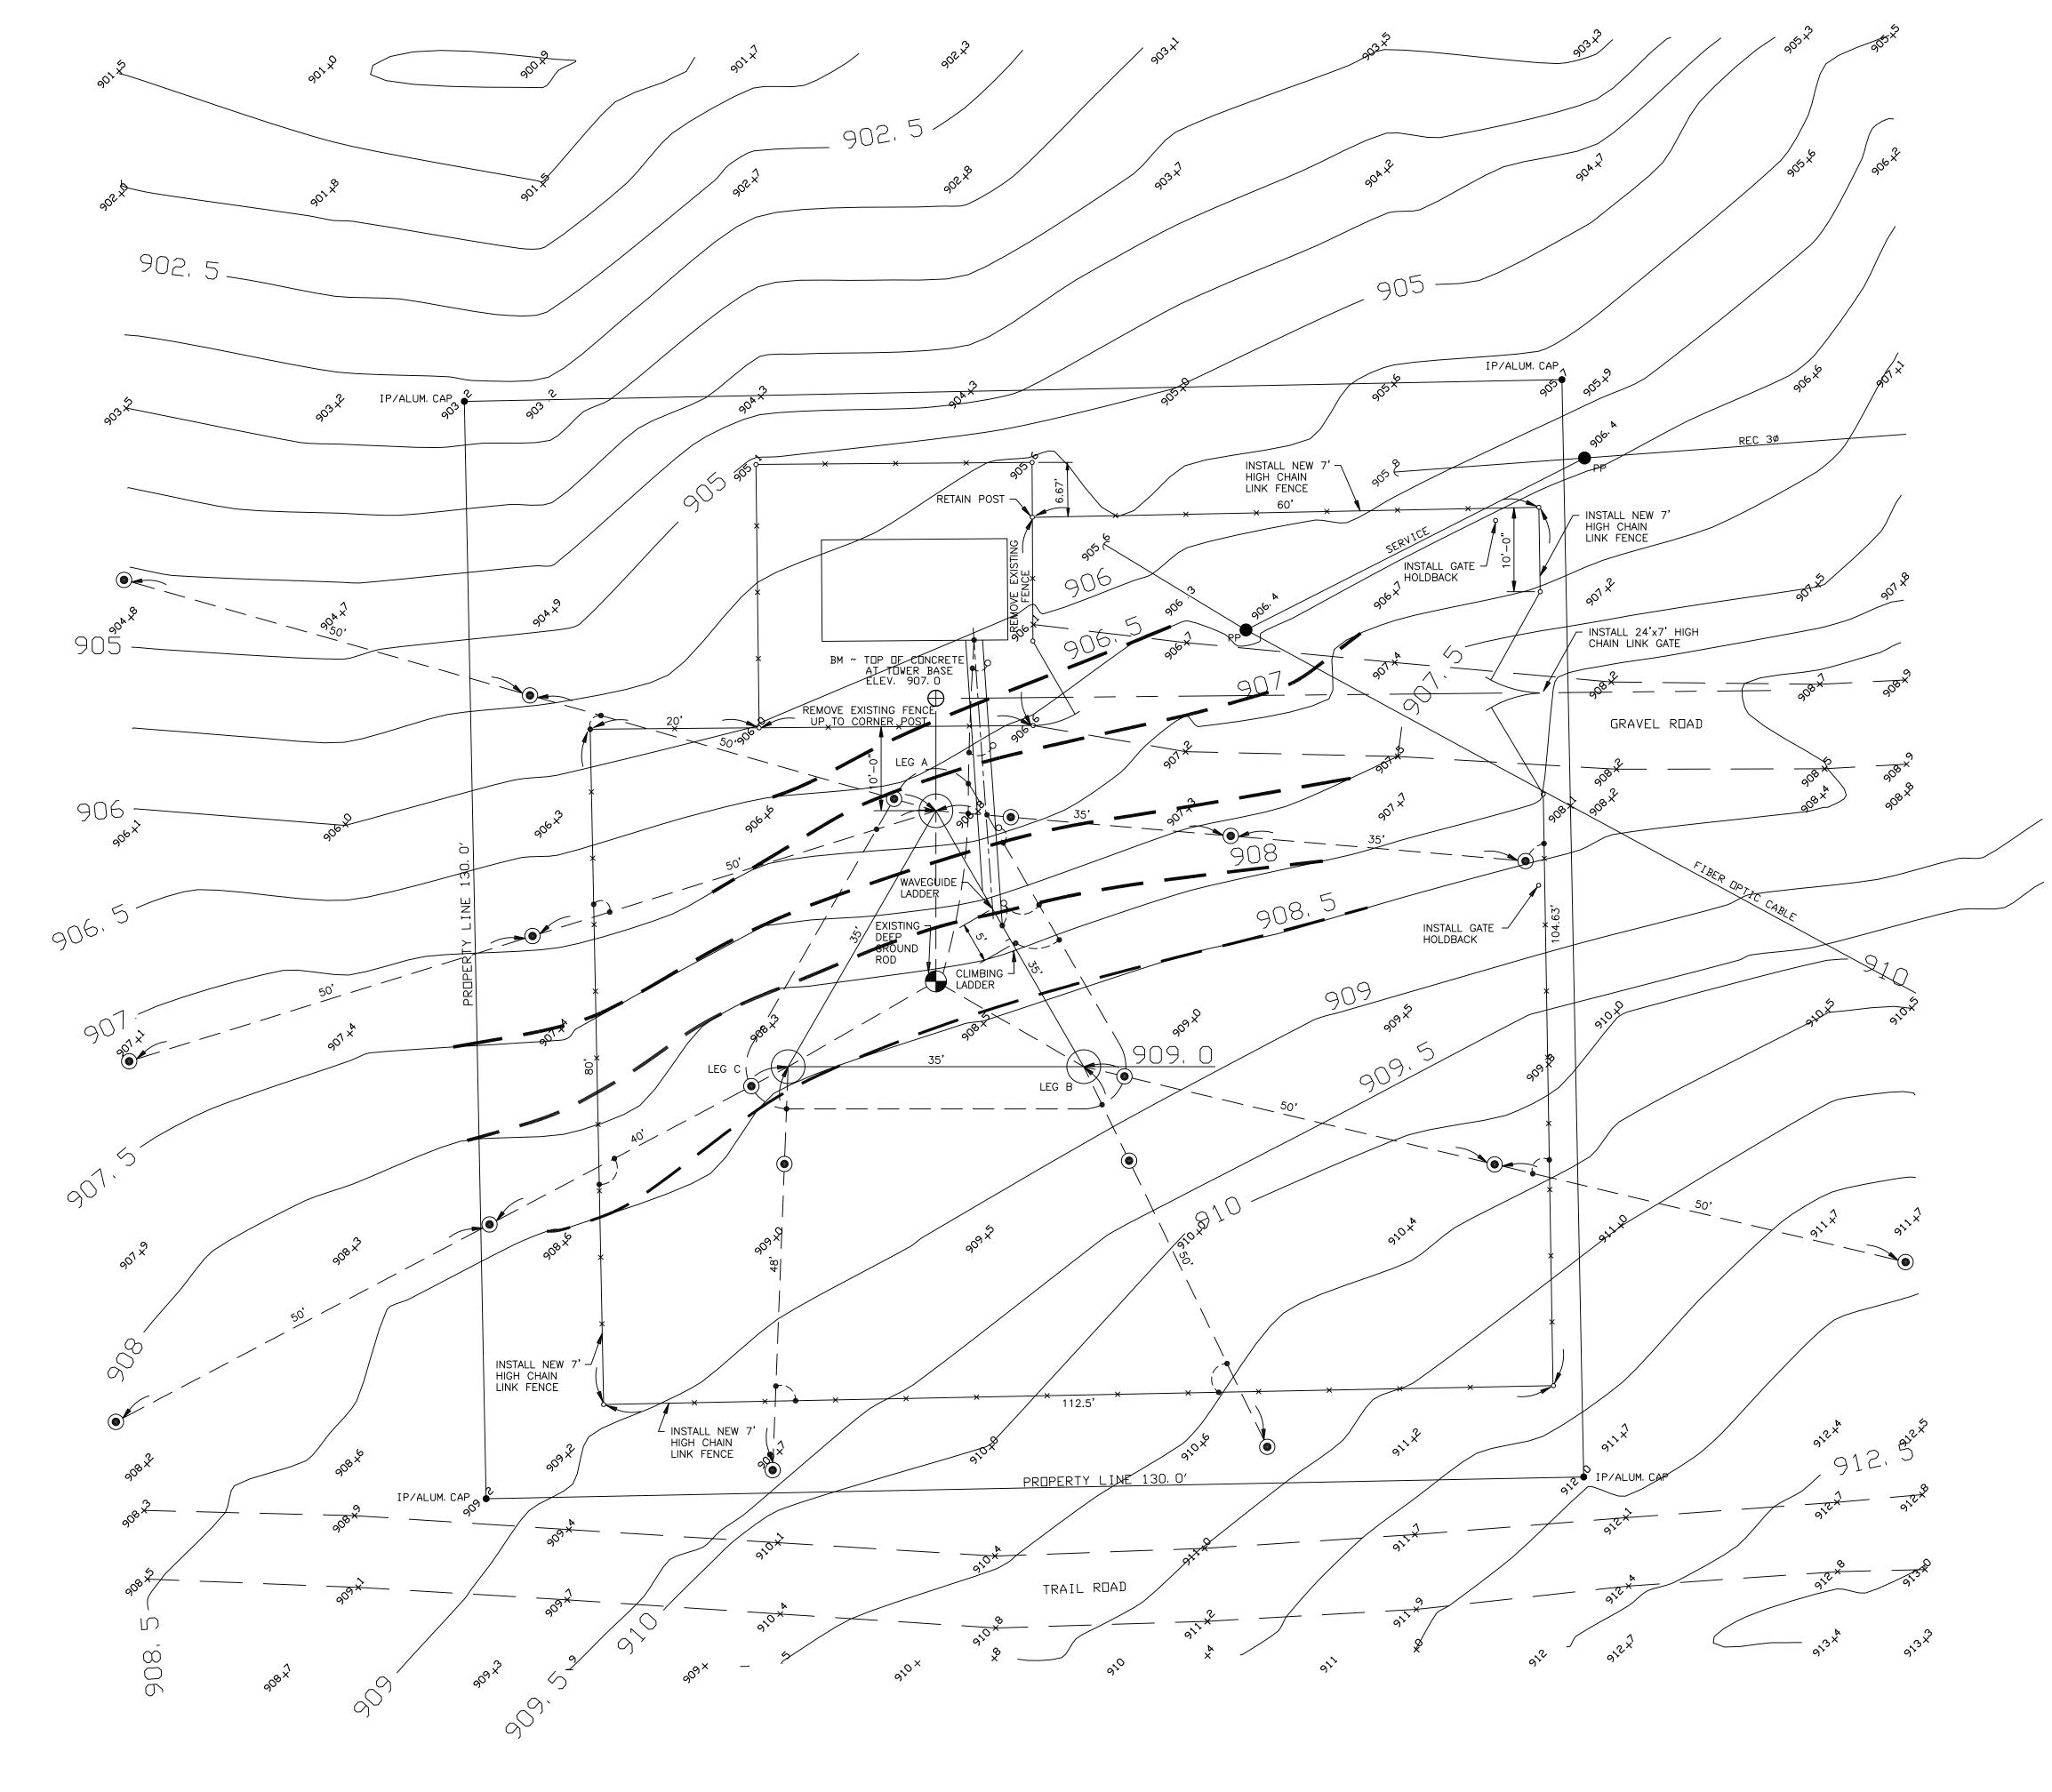


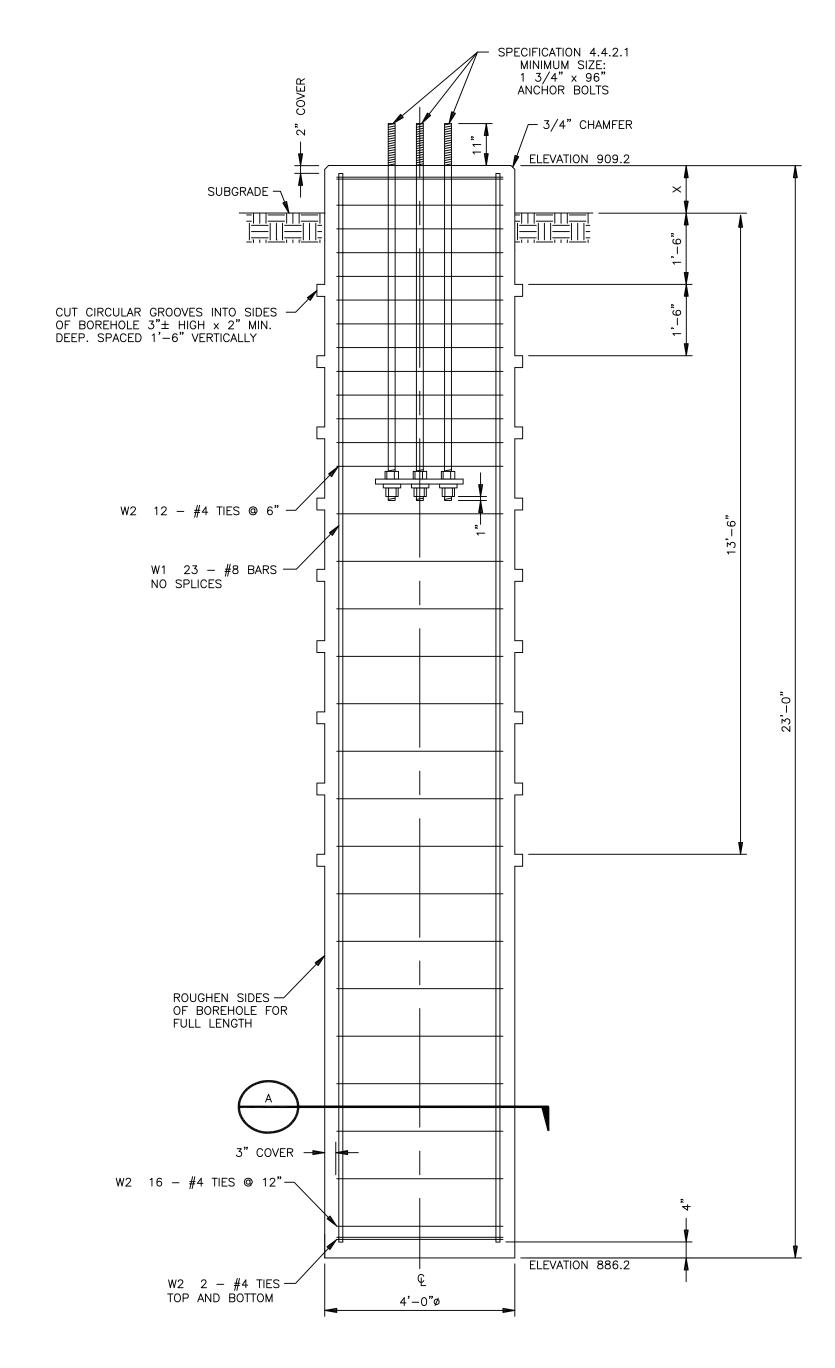

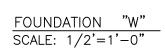

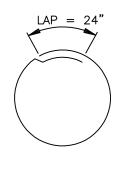

TYPICAL BEND

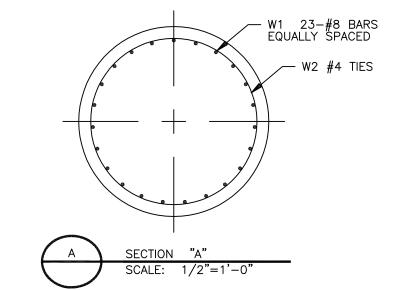


		REINFORCING STEEL FOR EACH FOUNDATION					
FOUNDATION	TOTAL NO. OF FOUNDATIONS	QTY	SIZE	LENGTH	MARK	TYPE	
W	7	23	8	22'-6"	W1	STRAIGHT	
	3	32	4		W2	Т3	
ALL REINFORCING STEEL SHALL BE ASTM A615 GRADE 60.							

STRUCTURE SITE GRADING SCHEDULE									
PIER	TOP OF PIER ELEVATION	LEG "A"		LEG "B"		LEG "C"			
PIER		CUT/FILL	"X"	CUT/FILL	"X"	CUT/FILL	"X"		
W	909.2	F 0.5'	2.0'	F 0.0'	0.4	F 0.0'	0.8'		

- 1. OUTSIDE-TO-OUTSIDE DIAMETER OF NO. 4 CIRCULAR TIES SHALL BE 42". DRILLED PIER CONSTRUCTION SHALL CONFORM TO REQUIREMENTS OF THE PROJECT SPECIFICATIONS.
- 3. GEOTECHNICAL REPORT AVAILABLE FROM COTR.

	Reference Old drawing number:								
				UNITED STATES DEPARTMENT OF ENERGY SOUTHWESTERN POWER ADMINISTRATION TULSA, OKLAHOMA					
				WELEETKA RADIO STATION					
				MICROWAVE TOWER FOUNDATION DRILLED PIER DETAILS					
				SCALE NOTED DRAWING NUMBER					
				DRAWN DK RS19-C8301					
				CHECKED HM KS19-COSUI					
				SUBMITTED HM FILE NAME SHEET NUMBER					
REV	DESCRIPTION	DRAWN	CHKD	APPROVED LH C8301 1 OF 1					

NOTES:

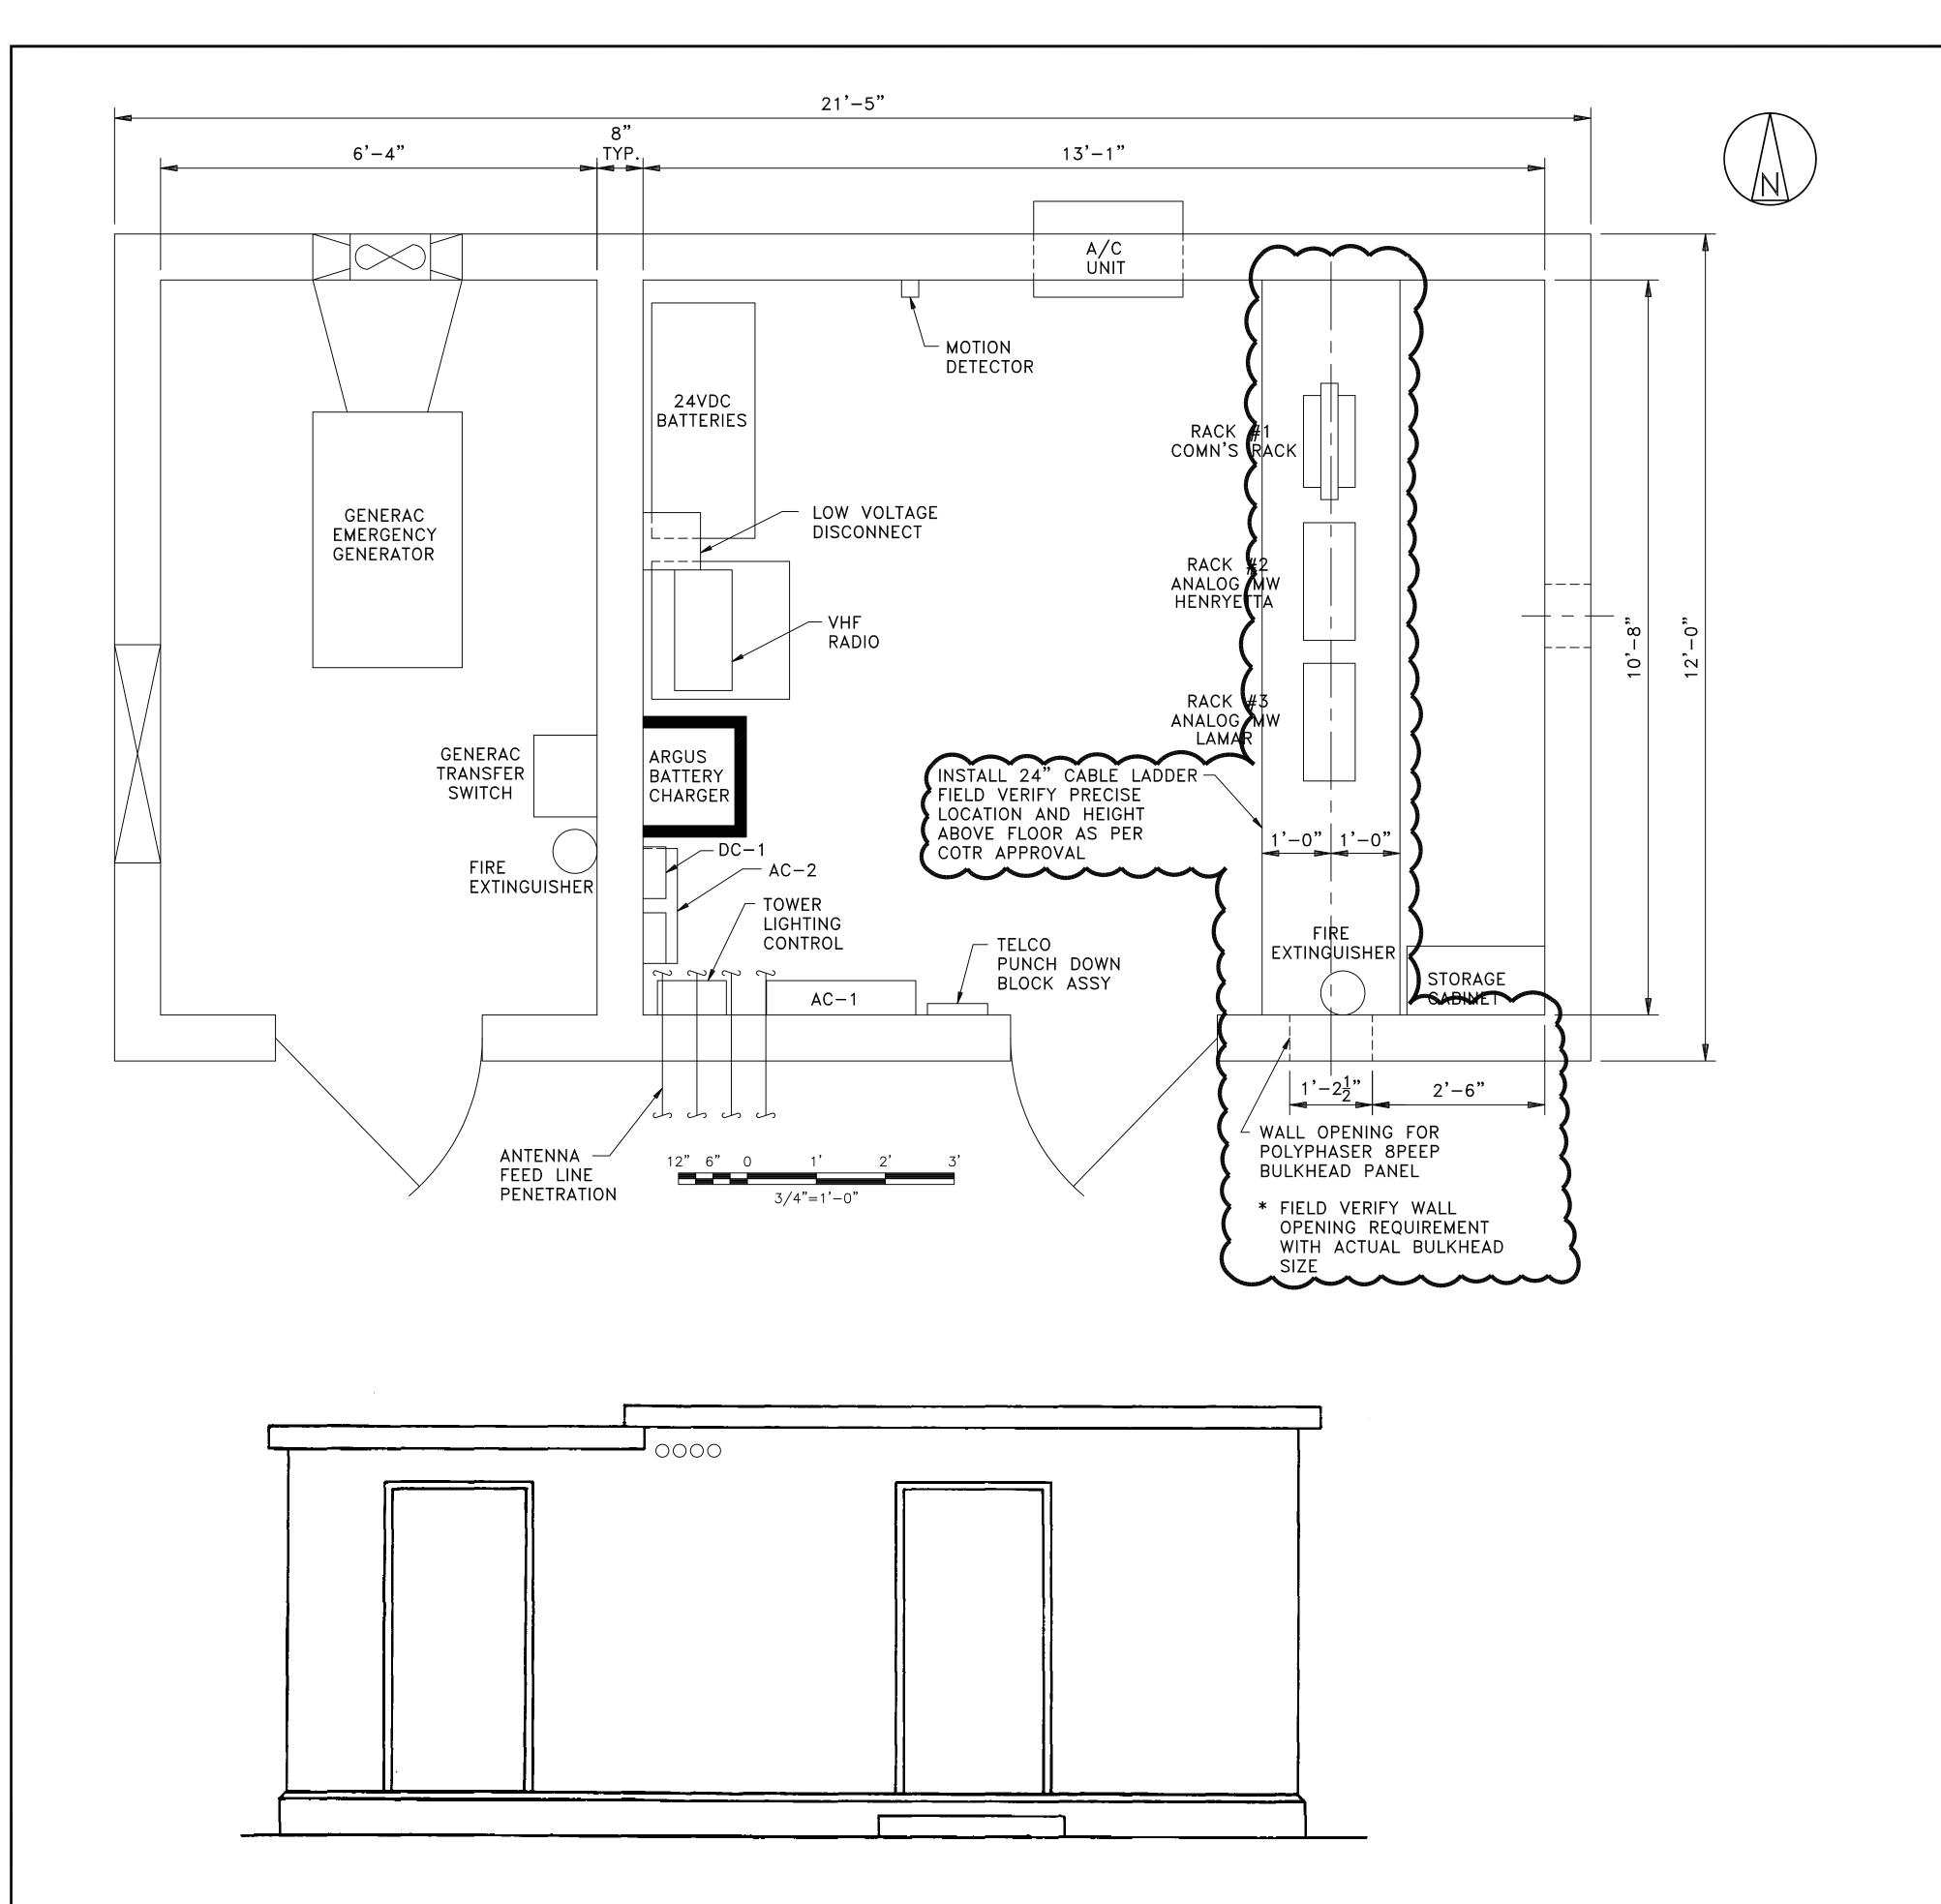

SOUTH ELEVATION

NOT TO SCALE

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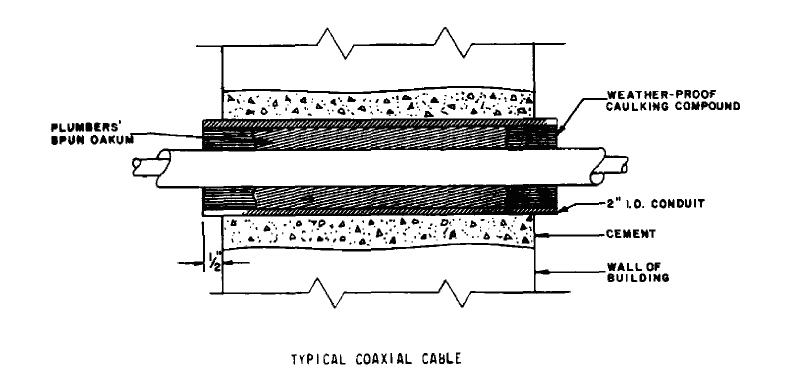
1. SEE DWG RS19-C8002 FOR SITE PLAN.

SEE DWG RS19-C8501 FOR RADIO ROOM WALL ELEVATIONS.
 SEE DWG RS19-C8502 FOR GENERATOR ROOM WALL ELEVATIONS.

4. SEE DWG RS19-E2001 FOR PANEL SCHEDULES & ONE LINE

5. SEE DWG RS19-E3200 FOR GROUNDING PLAN

ITEM	REGD	DESCRIPTION
	ı	CIRCUIT BREAKER PANELBOARD 120/240 VAC 10 3 WIR
2	1	ONAN GENERATOR CONTROL PANEL
3	1	JUNCTION BOX 9"-12"-4" DEEP WITH COVER
4	3	HANDY BOX COVER APPLETON #2510
5		RELIABLE TERMINAL BOARD
6	3	HANDY BOX COVER APPLETON #2510
7	1	AMPERES METER
8		4" SQUARE OUTLET BOX APPLETON #721712
9	1	SQUARE OUTLET BOX COVER #8487
10		WALL RECEPTACLE BREAKER
. 11		C-H CONTROL CIRCUIT BREAKER
12	3	RECEPTACLE 3 WIRE GROUNDING 15 AMPERE 125 VAC
13	1	MAIN CIRCUIT BREAKER
14		SOLAR TRANSFORMER
15	80ft	THIN WALL CONDUIT, GALVANIZED, 1"
16	50ft	THIN WALL CONDUIT, GALVANIZED, 1-2"
17	4	THIN WALL CONDUIT, GALVANIZED, I T, 90° BEND
18	ı	8' BASEBOARD HEATER
19		FIRE EXTINGUISHER
20	4	EMT CONECTOR 1士"
21	ı	METAL UTILITY CABINET
22	- 1	AIRCONDITIOR
23	2	CROUSE HINDS CONDULET T57-MT
24	1	CROUSE HINDS CONDULET T17-MT
25	6	THIN WALL CONDUIT CLAMPS & EMT
26	3	THIN WALL CONDUIT CLAMPS 1- EMT
27	1	ONAN AUTO TRANSFER SWITCH
28	4	24 VOLT BATTERIES
	60ft	#6 TW STRANDED COPPER WIRE
30		SPA BR 105 BASE RADIO
31	3ft	CONDUIT, FLEXIBLE 2"
	700'	#12 TW SOLID COPPER WIRE
33	1	SPA BR 109 BASE RADIO
34	 	400 MHZ FARRINON RADIO
35		FAN 5K GENERATOR
36 37	, <u>I</u>	SPA BR 105 BASE RADIO
<u>J</u>	2	FLEXIBLE CONDUIT CONNECTOR + "



THROUGH BUILDING WALL

DETAIL A NO SCALE

Reference Old drawing number: EE-0-RS19-0011

				UNITED STATES DEPARTMENT OF ENERGY SOUTHWESTERN POWER ADMINISTRATION TULSA, OKLAHOMA				
5	ADDITION OF CABLE LADDER AND 8-PORT BULKHEAD PANEL	DK 02-06	HM 02-06	WELEETKA RADIO STATION				
4	AS-BUILT	DIK 10-04	SWC 10-04	RADIO BUILDING EQUIPMENT PLAN				
7	FIELD AS-BUILT REVISIONS	GBJ 12-02	CMP 12-02	SCALE	NOTED	DRAWING NUMBER		
J				DRAWN	GBJ	RS19-C	2500	
2	ADDED DETAIL "A" FROM DELETED DWG EE-O-RS19-15	RLD	JJ	CHECKED	СМР	11319-0	0300	
2	DELETED DWG EE-0-RS19-15	04-87	04-87	SUBMITTED	СМР	FILE NAME	SHEET NUMBER	
REV	DESCRIPTION	DRAWN	CHKD	APPROVED		C8500	1 OF 1	

| Border name: ATASLZUT | Last Edited: 02/24/06 14:00:41 | Last File Name: Z:\Radio_Stations\Weleetka\A29030_—_Radio_Tower_Upgrade_—_Harry_Mardirosian\(